




FLOOR PLAN

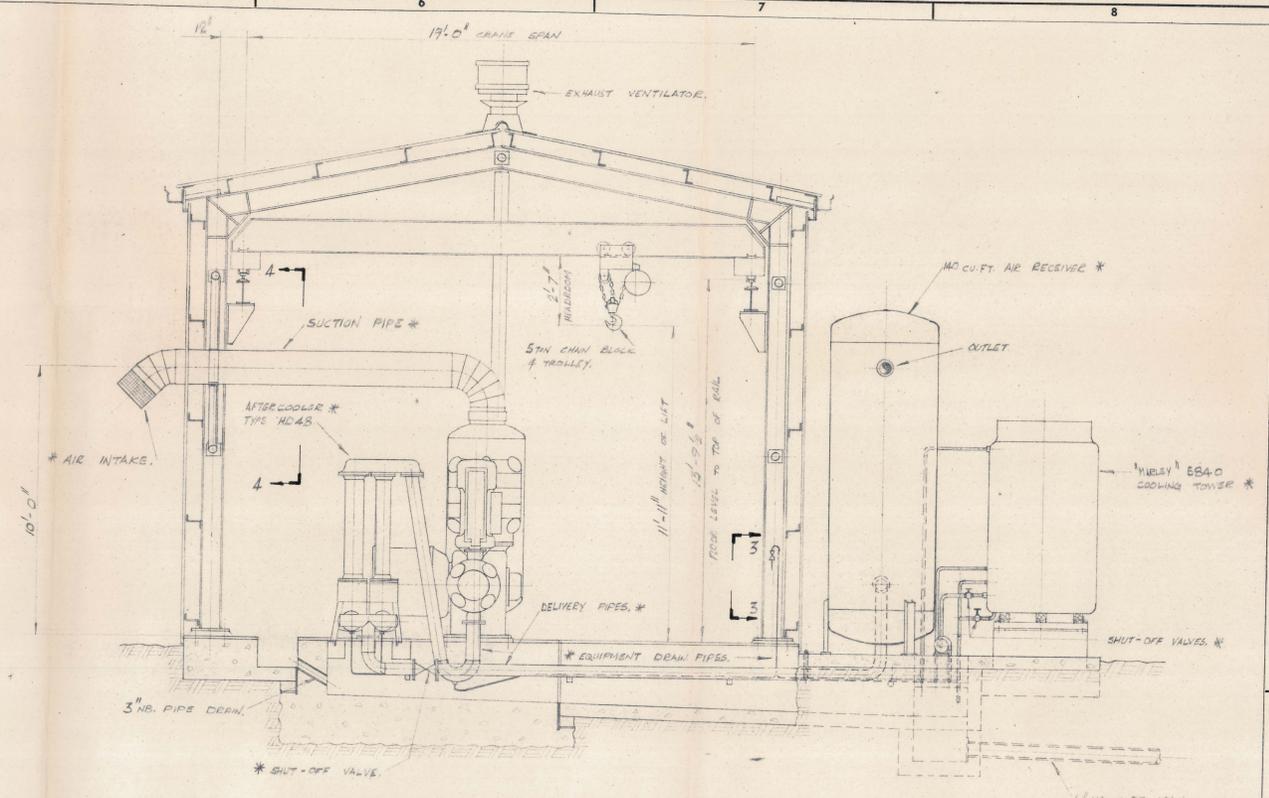

SECTION 1-1

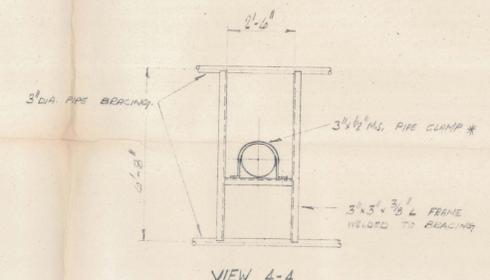

VIEW 4-4

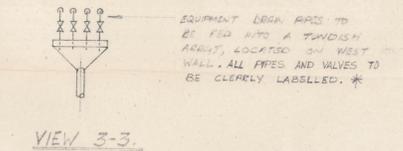


VIEW 3-3

REFERENCE DRAWINGS

- FOUNDATION PLAN & DETAILS 4-Q-015.
- STRUCTURAL ARRAT & ARCHITECTURAL DETAILS 4-Q-016.
- STRUCTURAL DETAILS SHEET 1. 4-Q-017.
- STRUCTURAL DETAILS SHEET 2. 4-Q-018.
- AFTERCOOLER & COOLING TOWER FINISH DETAILS 4-Q-019.
- 1000 GALLON WATER TANK STAND DETAILS 4-Q-020.
- OVERHEAD TRAVELLING GANTRY ARRAT & DETS. 2-S-003.
- ARCHITECTURAL DETAILS - SHT. 2. 4-Q-021.

GENERAL NOTES

- 1 - PIPE RUNS TO COOLING TOWER ARE SHOWN FOR CLARITY ONLY. ACTUAL RUNS WILL BE DETERMINED ON SITE TO THE SATISFACTION OF K.I.S. ENGINEER.
- 2 - CEMENT SCAFFOLD AFTER INSTALLATION OF MACHINERY.
- 3 - SURFACE TREATMENT OF ALL STEELWORK/PIPING, IN THIS INSTALLATION CONTRACT, SHALL CONSIST OF POWER WIRE BROOMING AND PAINTING WITH ONE COAT OF TRUBHANS INTERNATIONAL SANDLINE GEEY METAL PRIMER 78024. ONE FINISH COAT OF TRUBHANS EPONEX ENAMEL SHALL BE APPLIED ON SITE PRIOR TO INSTALLATION AND ONE FINISH COAT AFTER INSTALLATION.
- 4 - COLOUR CODING SHALL BE IN ACCORDANCE WITH AS.021-1967 COLOURS SHALL BE IN ACCORDANCE WITH BS.381C-1964 (ENDORSED AS BS.1185-1968) AS FOLLOWS:-
 STRUCTURAL STEELWORK & CHECKER PLATE COVERS -
 FIRST FINISH COAT - No. 020 - GEEY.
 FINAL FINISH COAT - No. 027 - GEEY.
 OVERHEAD TRAVELLING GANTRY & VALVES - No. 356 - YELLOW.
 WATER PIPES - No. 220 - GREEN.
 SUCTION SILENCER, AIR INTAKE & PIPES - No. 112 - BLUE.
 AIR RECEIVER - No. - WHITE.
- 5 - ITEMS MARKED THIS * ARE TO BE SUPPLIED BY COMPRESSOR MANUFACTURER.

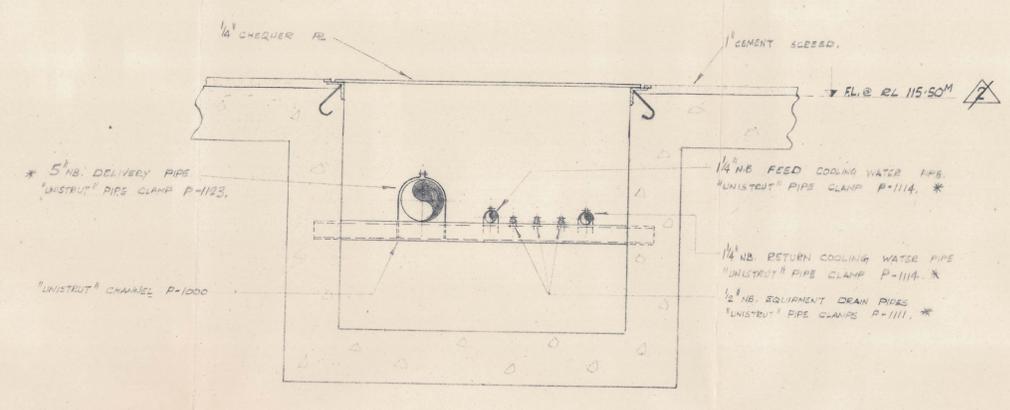

SECTION 2-2
SCALE - 1/2" = 1'-0"

0324-929

| | | | | | | | |
|----------|--|----------|--|---------|--|-----------|--|
| DRAWN | | TRACED | | CHECKED | | APPROVED | |
| BY | | BY | | BY | | BY | |
| DATE | | DATE | | DATE | | DATE | |
| NO. ZONE | | REVISION | | NOTES | | ISSUED TO | |
| | | | | | | | |
| | | | | | | | |

KING ISLAND SCHEELITE LTD
BOLD HEAD PROJECT
COMPRESSOR HOUSE
GENERAL ARRANGEMENT

SCALE 3/8" = 1'-0" MIN.
DATE 17-4-72
2-S-002/3
FIG. 2A